
MUNICIPALITY OF SKAGWAY AB MOUNTAIN COMMUNICATION FACILITY SITE IMPROVEMENTS SKAGWAY, ALASKA



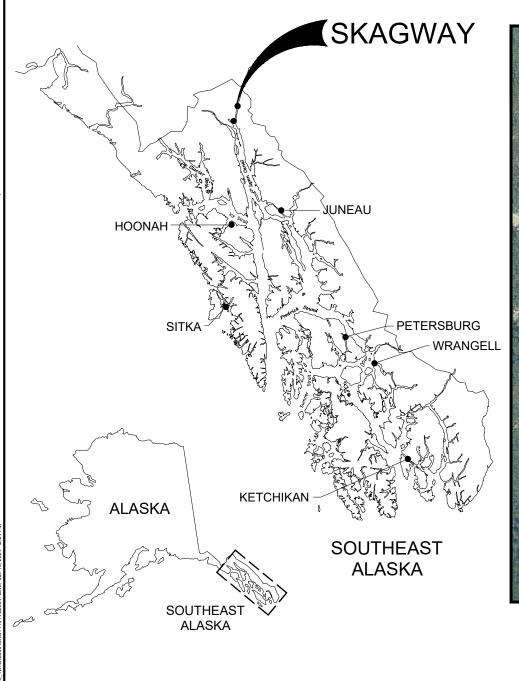

PROJECT LOCATION MAP

SHEET INDEX					
SHEET No. SHEET TITLE					
C001	COVER SHEET				
C002	GENERAL NOTES, ABBREVIATIONS & SYMBOLS				
C100	EXISTING SITE TOPOGRAPHY & SURVEY CONTROL				
C101	EXISTING SITE PHOTOS				
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C401	CONSTRUCTION DETAILS				
C402	CONSTRUCTION DETAILS				

BOROUGH MAYOR

SAM BAS

BOROUGH ASSEMBLY

ORION HANSON
JAY BURNHAM
KATE KOLODI
DEB POTTER
DAN HENRY
ALEXANDRIA WEDDELL

BOROUGH ADMINISTRATOR

BRAD RY

PUBLIC WORKS DIRECTOR

TYSON AM

SHEET TITLE:
COVER SHEET

CONSTRUCTION DRAWINGS

MUNICIPALITY OF SKAGWAY
AB MOUNTAIN COMMUNICATION FACILITY
SITE IMPROVEMENTS

SKAGWAY, ALASKA









GENERAL CONSTRUCTION NOTES

- 1. TOPOGRAPHIC SURVEY USED FOR THESE DRAWINGS WAS PERFORMED BY RESPEC ON JUNE 29, 2022.
- BEDROCK, GRAVEL, SAND, COBBLES, ORGANICS AND GROUND WATER MAY BE ENCOUNTERED AT VARIOUS DEPTHS DURING FENCE POST EXCAVATION OPERATIONS. NO GEOTECHNICAL EXPLORATION WAS PERFORMED FOR THIS PROJECT. EXPOSED BEDROCK IS VISIBLE ON THE PROJECT SITE.
- CONNECTIONS TO EXISTING GRAVEL SURFACES ARE APPROXIMATE AND SHALL BE FIELD VERIFIED BY THE CONTRACTOR PRIOR TO BEGINNING CONSTRUCTION.
- LOCATIONS OF EXISTING UNDERGROUND TELEPHONE, CABLE TELEVISION AND POWER UTILITIES SHOWN ON THESE PLANS WERE DERIVED FROM MUNICIPALITY OF SKAGWAY AS-BUILTS OR FIELD LOCATES. ACTUAL LOCATIONS MAY VARY FROM THOSE SHOWN. THE CONTRACTOR IS RESPONSIBLE FOR LOCATING. PROTECTING, AND MAINTAINING THE UTILITIES THROUGHOUT THE CONSTRUCTION OF THIS PROJECT. ANY DAMAGE RESULTING TO THESE UNDERGROUND UTILITIES DURING CONSTRUCTION SHALL BE PAID FOR BY THE CONTRACTOR AND SHALL BE CONSIDERED INCIDENTAL TO THE CONTRACT. CALL MUNICIPALITY OF SKAGWAY PUBLIC WORKS DEPARTMENT AT 983-2449, PRIOR TO ANY EXCAVATION ACTIVITIES.
- ALL NON-CONTAMINATED ITEMS DESIGNATED TO BE REMOVED SHALL BE DISPOSED OF AT THE MOS 15 ACRE DISPOSAL SITE. COORDINATE WITH MOS PUBLIC WORKS DIRECTOR ON SPECIFIC DISPOSAL PILE LOCATIONS. A FEE MAY BE CHARGED BY MOS FOR DISPOSAL.
- 6. CONTRACTOR SHALL REFERENCE ALL EXISTING SURVEY MONUMENTS PRIOR TO CONSTRUCTION THAT WILL BE DISTURBED DURING HIS WORK, AND REMONUMENT AFTER CONSTRUCTION OPERATIONS, ALL WORK SHALL BE DONE BY, OR UNDER THE DIRECTION OF, AN ALASKA REGISTERED LAND SURVEYOR. ALL EXISTING SURVEY
- 7. THE CONTRACTOR SHALL INSTALL AND MAINTAIN EROSION CONTROL DEVICES DURING CONSTRUCTION, AS INDICATED ON THE CONTRACTOR'S APPROVED EROSION AND SEDIMENT CONTROL PLANS.
- THE CONTRACTOR SHALL PERFORM WORK IN ACCORDANCE WITH MOS NOISE ORDINANCE REQUIREMENTS PER CHAPTER 9.03 NOISE CONTROL OF THE MOS MUNICIPAL CODE. THIS IS FROM 6:00AM TO 10:00PM DURING THE CONSTRUCTION SEASON.
- 9. THE CONTRACTOR SHALL PROVIDE A MINIMUM OF 72 HOURS ADVANCE NOTICE PRIOR TO BEGINNING CONSTRUCTION TO THE FOLLOWING COMPANIES / INDIVIDUALS WHO USE / OPERATE ON THE SITE:
 - TYSON AMES, MOS PUBLIC WORKS DIRECTOR (907) 612-0051
 - AT&T (907)-983-3399
 - GCI (800)-770-0725
 - STATE OF ALASKA
- 10. THE CONTRACTOR SHALL ENSURE THAT THE LOWER ACCESS CONTROL GATE IS CLOSED AND LOCKED AT THE END OF EACH WORK SHIFT TO MAINTAIN SITE SECURITY.

PROJECT COMPLETION SCHEDULE

PROJECT COMPLETION DATE FOR THIS WORK SHALL BE OCTOBER 1, 2024

FOR BASE BID OR ADDITIVE ALTERNATE No. 1 WORK IF AWARDED

ABBREVIATIONS

MAY


MAXIMIIM

ADDITIVE

ADD	ADDITIVE	MAX	MAXIMUM
ALT	ALTERNATE	MIN	MINIMUM
APPROX.	APPROXIMATE	MOS	MUNICIPALITY OF SKAGWAY
AT&T	AMERICAN TELEPHONE & TELEGRAPH	MTE	MATCH TO EXISTING
CMP	CORRUGATED METAL PIPE	N	NORTHING
CONC	CONCRETE	N/A	NOT APPLICABLE
CPP	CORRUGATED POLYETHYLENE PIPE	NFS	NON-FROST SUSCEPTIBLE
CTE	CONNECT TO EXISTING	No.	NUMBER
CY	CUBIC YARD	NTS	NOT TO SCALE
DI	DUCTILE IRON	OC	ON CENTER
DIP	DUCTILE IRON PIPE	OD	OUTER DIAMETER
DIA	DIAMETER	OSHA	OCCUPATIONAL SAFETY & HEA
DOT	STATE OF ALASKA DEPARTMENT OF		ADMINISTRATION
	TRANSPORTATION & PUBLIC FACILITIES	P/L	PROPERTY LINE
DWGS	DRAWINGS	PP	POWER POLE
E	EASTING	PSF	POUNDS PER SQUARE FOOT
(E)	EXISTING	PSI	POUNDS PER SQUARE INCH
EG	EXISTING GRADE	PT	POINT
EJ	EAST JORDAN	R	RADIUS
EL	ELEVATION	RP	RADIUS POINT
EP	EDGE OF PAVEMENT	RT	RIGHT
EQ	EQUAL	SCHD	SCHEDULE
EW	EACH WAY	STD	STANDARD
EXIST	EXISTING	TBM	TEMPORARY BENCH MARK
EXP	EXPANSION	TOB	TOP OF BANK
FG	FINISH GRADE	TOS	TOP OF SOIL
FT	FEET	TYP	TYPICAL
GB	GRADE BREAK	U/G	UNDERGROUND
GCI	GENERAL COMMUNICATIONS INC	UGU	UNDERGROUND UTILITY
ID	INSIDE DIAMETER	UON	UNLESS OTHERWISE NOTED
IE	INVERT ELEVATION	VERT	VERTICAL
L	LENGTH	W/	WITH
LT	LEFT	Ø	DIAMETER
M	METER		

SYMBOLS

EXISTING	PROPOSED	1		
		PROPERTY LINE		
		PROJECT BASELINE		
	P-1	STORM DRAIN PIPE		
, , , , , , , , , , , , , , , , , , ,	4 4 4	CONCRETE SURFACE		
		EDGE OF GRAVEL		
UGE		ELECTRIC LINE UNDERGROUND		
——— OHE ———		ELECTRIC LINE OVERHEAD		
		UTILITY POLE		
		SHOT ROCK SURFACE		
		GRAVEL SURFACE		
— — — — —		TOP OF BANK		
r ing ing ing ing gr		FILL SLOPE LIMITS		
110'		GROUND CONTOUR		
x x x	x x x	CHAIN LINK FENCE W/ BARBED WIRE		
		STRUCTURE		
OO		METAL SWING GATE		
	•	ROLLING GATE		
	o 10	FINISH GRADE POINT		
	•	DIRECTIONAL FLOW ARROW		
		SATELLITE		

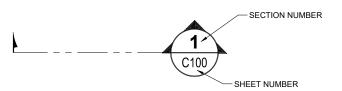

REFERENCE BUBBLE EXPLANATION

GENERAL NOTES, ABBREVIATIONS & SYMBOLS

PROJECT :

MUNICIPALITY OF SKAGWAY AB MOUNTAIN COMMUNICATION FACILITY SITE IMPROVEMENTS








11014.22004

C002

CONSTRUCTION DRAWINGS

SKAGWAY, ALASKA

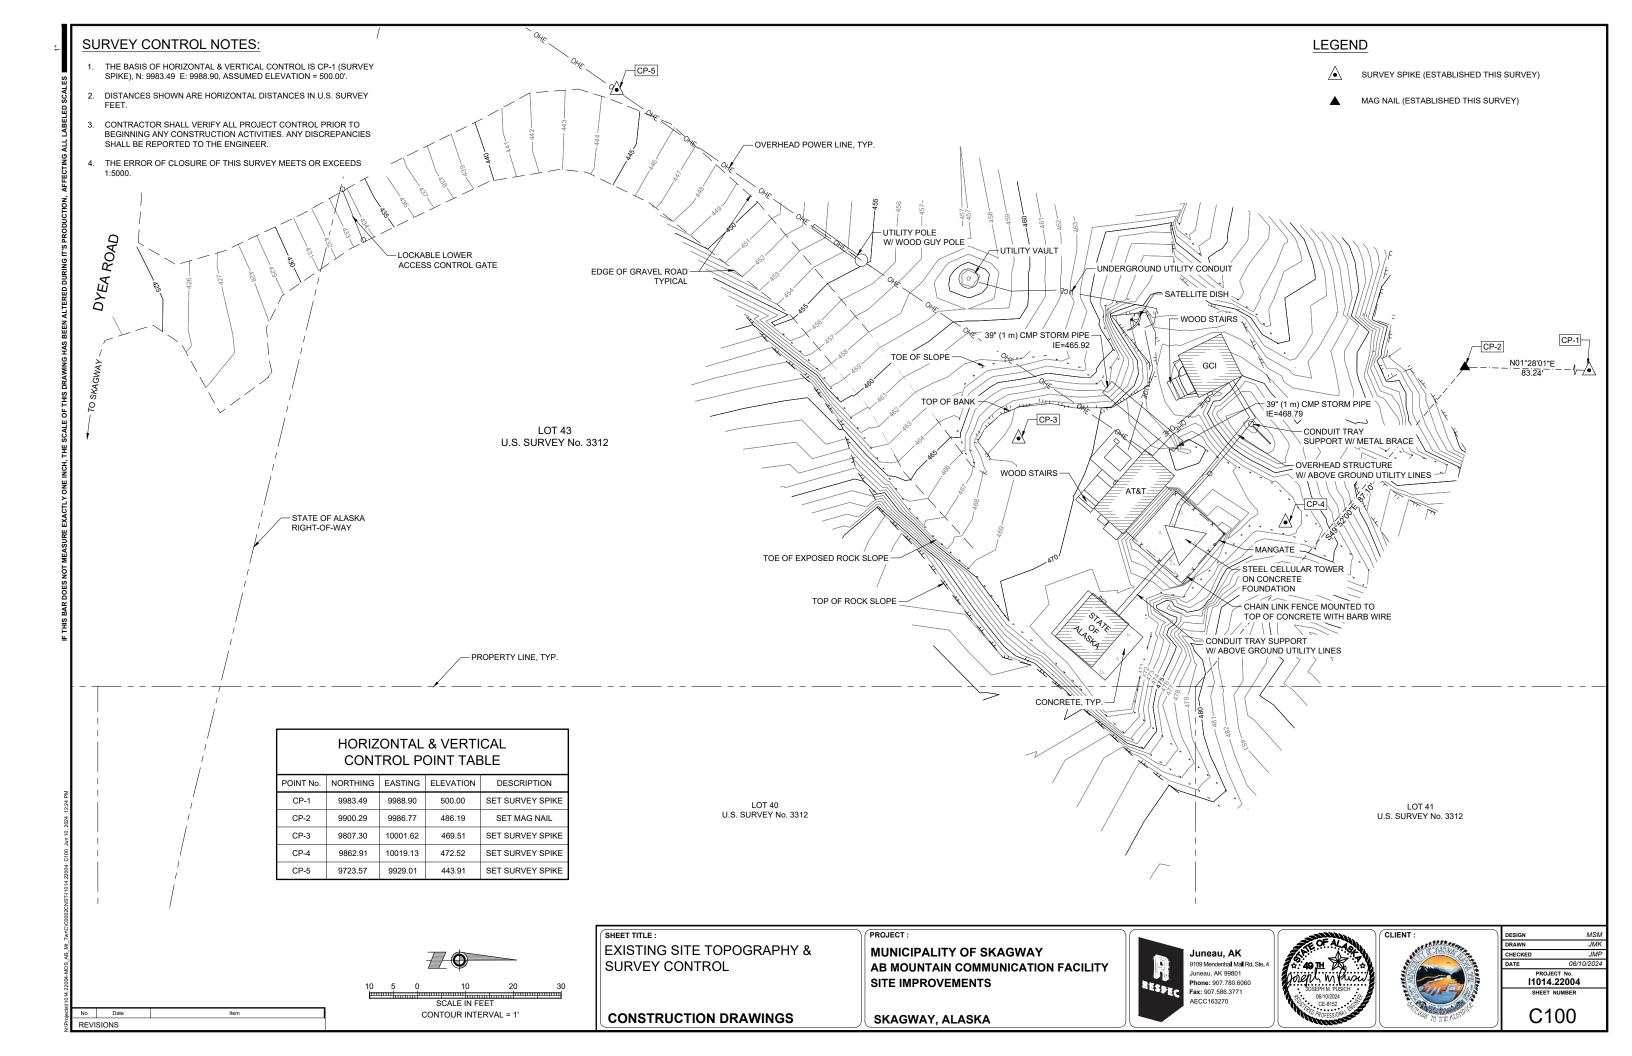





OUTLET OF 39" CMP CULVERT - VIEW LOOKING WEST (4)



FENCE AROUND AT&T TOWER - VIEW LOOKING SOUTH



GCI, AT&T AND STATE BUILDINGS - VIEW LOOKING NORTH



ROCK BETWEEN AT&T TOWER AND STATE BUILDING (5)VIEW LOOKING NORTH



ROCK ADJACENT TO GCI BUILDING - VIEW LOOKING WEST

Juneau, AK 9109 Mendenhall Mall Rd. Ste Juneau, AK 99801 Phone: 907.780.6060 Fax: 907.586.3771



PROJECT No. 11014.22004

C101

CONSTRUCTION DRAWINGS

SHEET TITLE :

SKAGWAY, ALASKA

EXISTING SITE PHOTOS

PROJECT: **MUNICIPALITY OF SKAGWAY** AB MOUNTAIN COMMUNICATION FACILITY SITE IMPROVEMENTS


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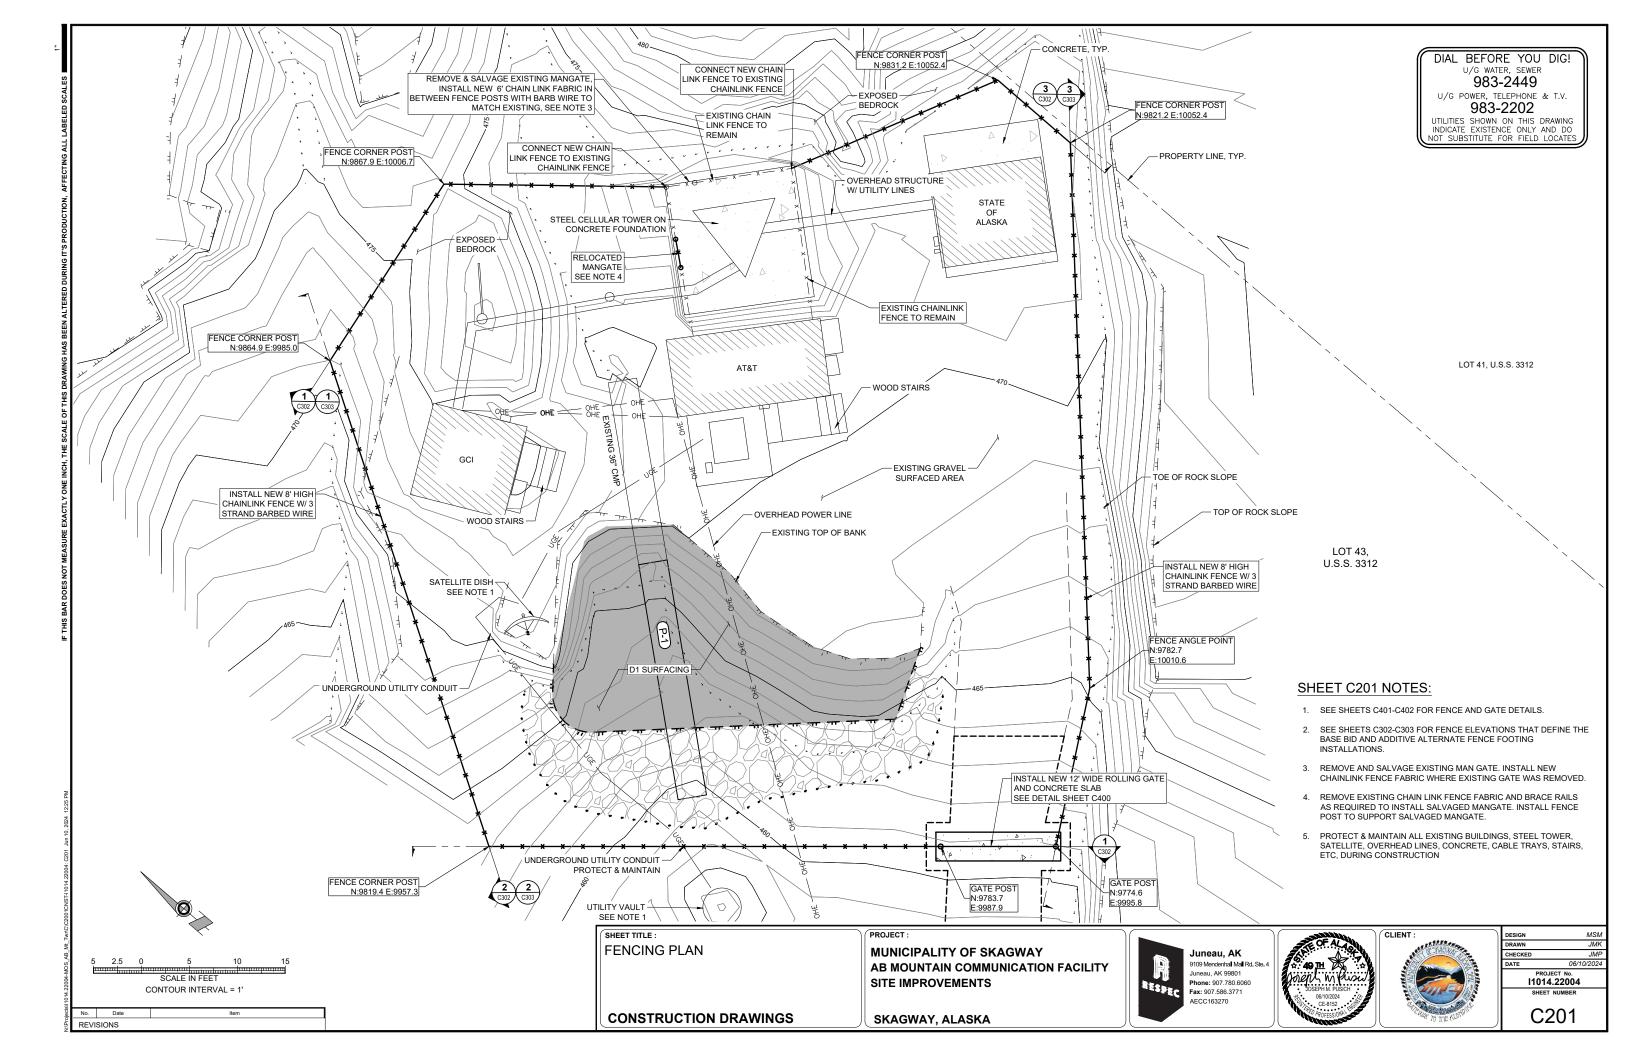



GCI AND AT&T BUILDING - VIEW LOOKING WEST (3)




ROCK BETWEEN AT&T TOWER & STATE BUILDING VIEW LOOKING WEST (6)



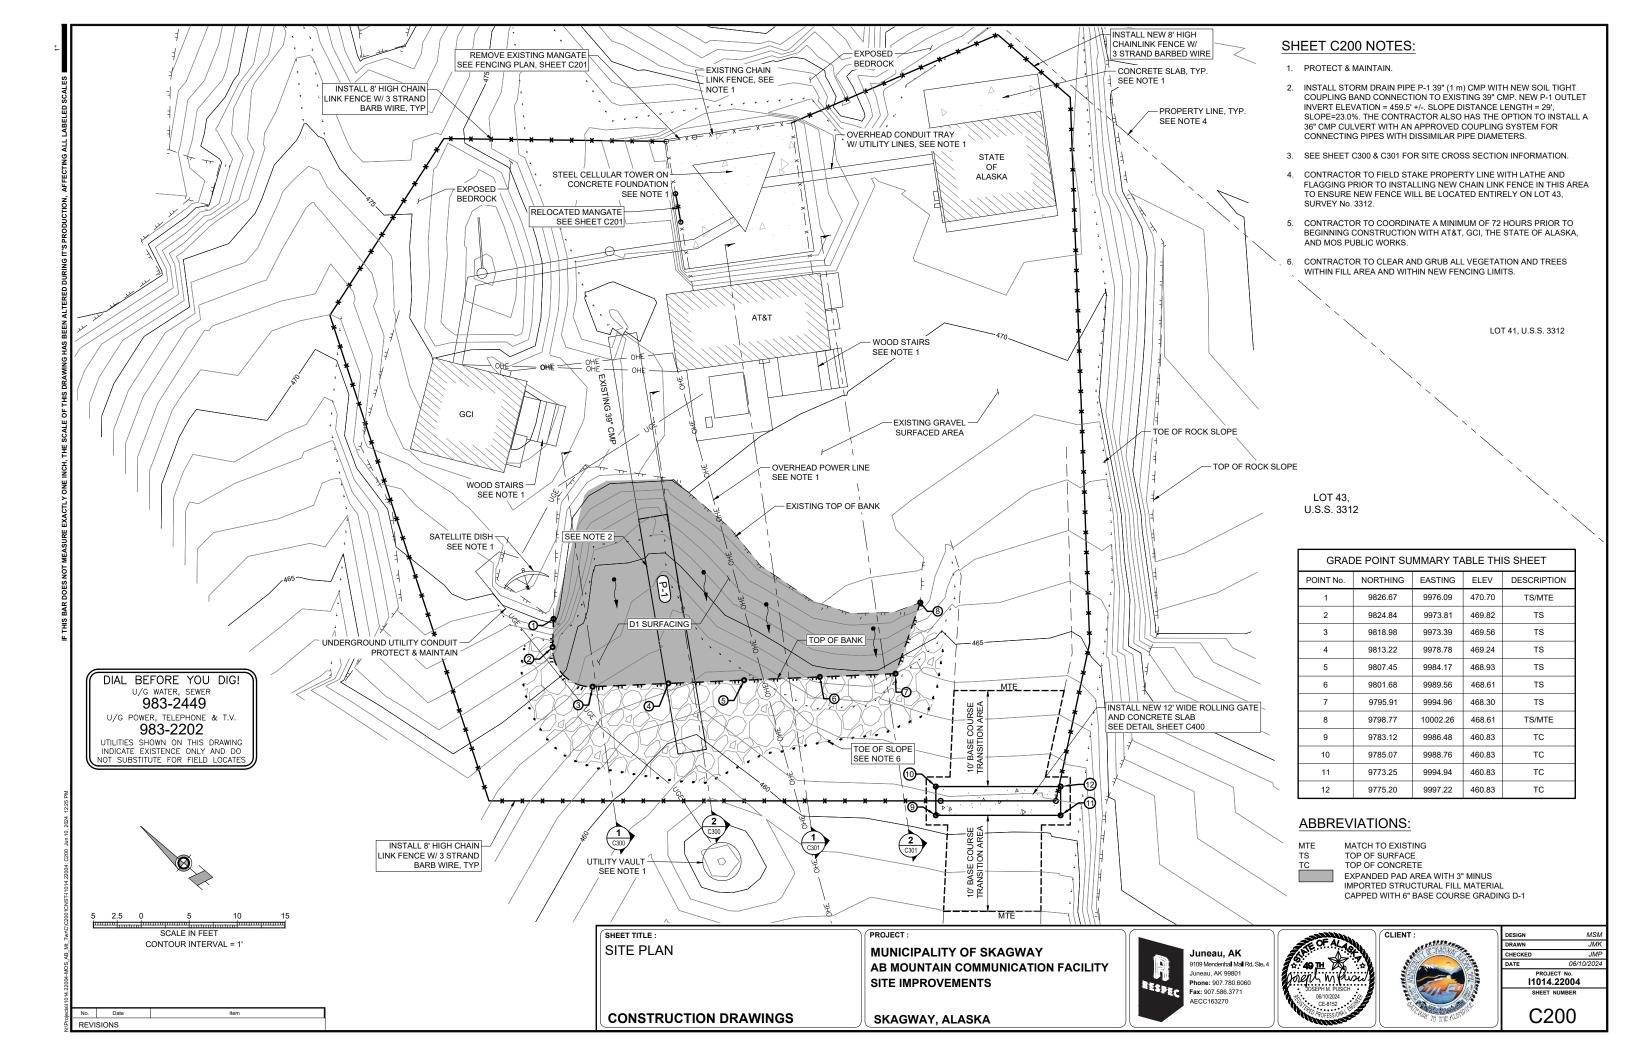

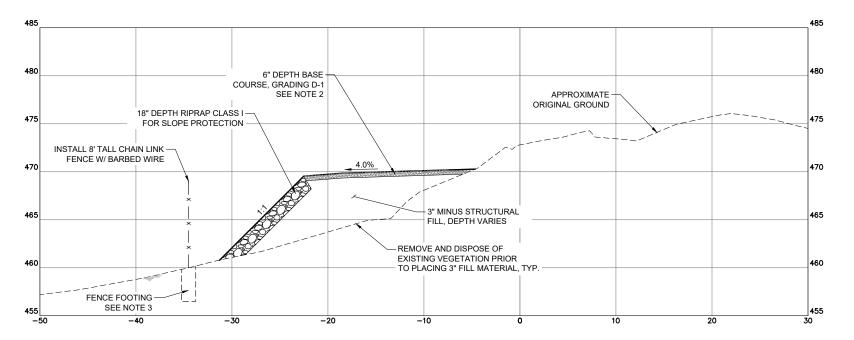



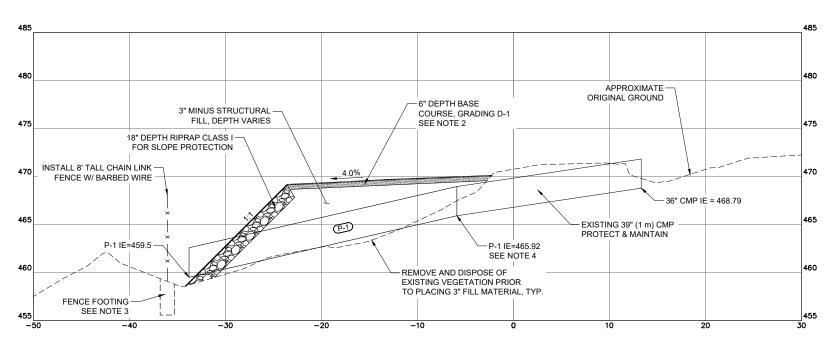

SECTION - VIEW LOOKING EAST

SHEET TITLE : TYPICAL SECTIONS

CONSTRUCTION DRAWINGS

SCALE: 1:1 H; 1:1 V

C300

MUNICIPALITY OF SKAGWAY

SKAGWAY, ALASKA





CLIENT :

SHEET C300 TYPICAL SECTION NOTES:

2. ALL BASE COURSE, GRADING D-1 SHALL BE COMPACTED TO 95% OF MAXIMUM DRY DENSITY UNIT WEIGHT. 3. CONTRACTOR TO BE AWARE THAT EXPOSED BEDROCK AND BOULDERS EXIST THROUGHOUT THE PROJECT SITE. 4. INSTALL STORM DRAIN PIPE P-1 39" (1 m) CMP WITH NEW SOIL TIGHT COUPLING BAND CONNECTION TO EXISTING 39" CMP. NEW P-1 OUTLET INVERT ELEVATION = 459.5' +/-. SLOPE DISTANCE

LENGTH=29', SLOPE=23.0%. THE CONTRACTOR ALSO HAS THE OPTION TO INSTALL A 36" CMP CULVERT WITH AN APPROVED

COUPLING SYSTEM FOR CONNECTING PIPES WITH DISSIMILAR PIPE

1. SEE SHEET C200 FOR SITE SECTION LOCATIONS.

DIAMETERS.

11014.22004

C300

AB MOUNTAIN COMMUNICATION FACILITY SITE IMPROVEMENTS

PROJECT:


SECTION - VIEW LOOKING EAST

C300

SCALE: 1:1 H; 1:1 V

SHEET C301 TYPICAL SECTION NOTES:

- 1. SEE SHEET C200 FOR SITE SECTION LOCATIONS.
- 2. ALL BASE COURSE, GRADING D-1 SHALL BE COMPACTED TO 95% OF MAXIMUM DRY DENSITY UNIT WEIGHT.
- 3. CONTRACTOR TO BE AWARE THAT EXPOSED BEDROCK AND BOULDERS EXIST THROUGHOUT THE PROJECT SITE.

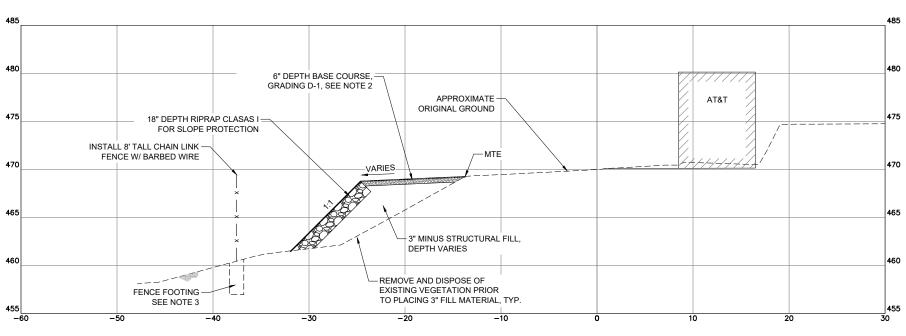

2 SECTION - VIEW LOOKING EAST
C300 SCALE: 1:11+; 1:11 V

SHEET TITLE:
TYPICAL SECTIONS

CONSTRUCTION DRAWINGS

MUNICIPALITY OF SKAGWAY
AB MOUNTAIN COMMUNICATION FACILITY
SITE IMPROVEMENTS

SKAGWAY, ALASKA

PROJECT:





CLIENT:

DESIGN
DRAWN
CHECKED
DATE 06/10/
PROJECT No.
11014.22004
SHEET NUMBER

SHEET NUMBER
C301

No. Date Item
REVISIONS

